


**EXPANSION FLOOR PLAN**  
SCALE: 1/8" = 1'-0"

**STEP #5 - LEVELING ASSEMBLED FRAME & SECURING TO FLOOR**

\* A LEVEL WILL BE REQUIRED




- 5.1 USING A LEVEL ON ITEM D AND ADJUSTING THE LEVELING FEET, TILT THE ASSEMBLED FRAME SLIGHTLY OUT OF LEVEL. (THIS OFFSET WILL BE CORRECTED WHEN FRAME IS LOADED UP DURING NORMAL OPERATION).
- 5.2 REPEAT STEP 5.1 FOR OPPOSITE SIDE.
- 5.3 RECONFIRM FINAL LOCATION OF FRAME PRIOR TO DRILLING HOLES ON THE FLOORING. DRILL 1/2" DIAMETER HOLE INTO FLOOR TO THE REQUIRED DEPTH, VIA RE-DRILLED LUGGING HOLES ON ITEM B & D.
- 5.4 SECURE ITEM B & D TO FLOOR WITH SUPPLIED HARDWARE.
- 5.5 VISUALLY INSPECT ALL BOLTS ARE MECHANICALLY SECURE BEFORE PROCEEDING TO NEXT STEP.

Top View  
Electric Rug Gallery  
3'x12' 30 arm  
Free standing frame foot print

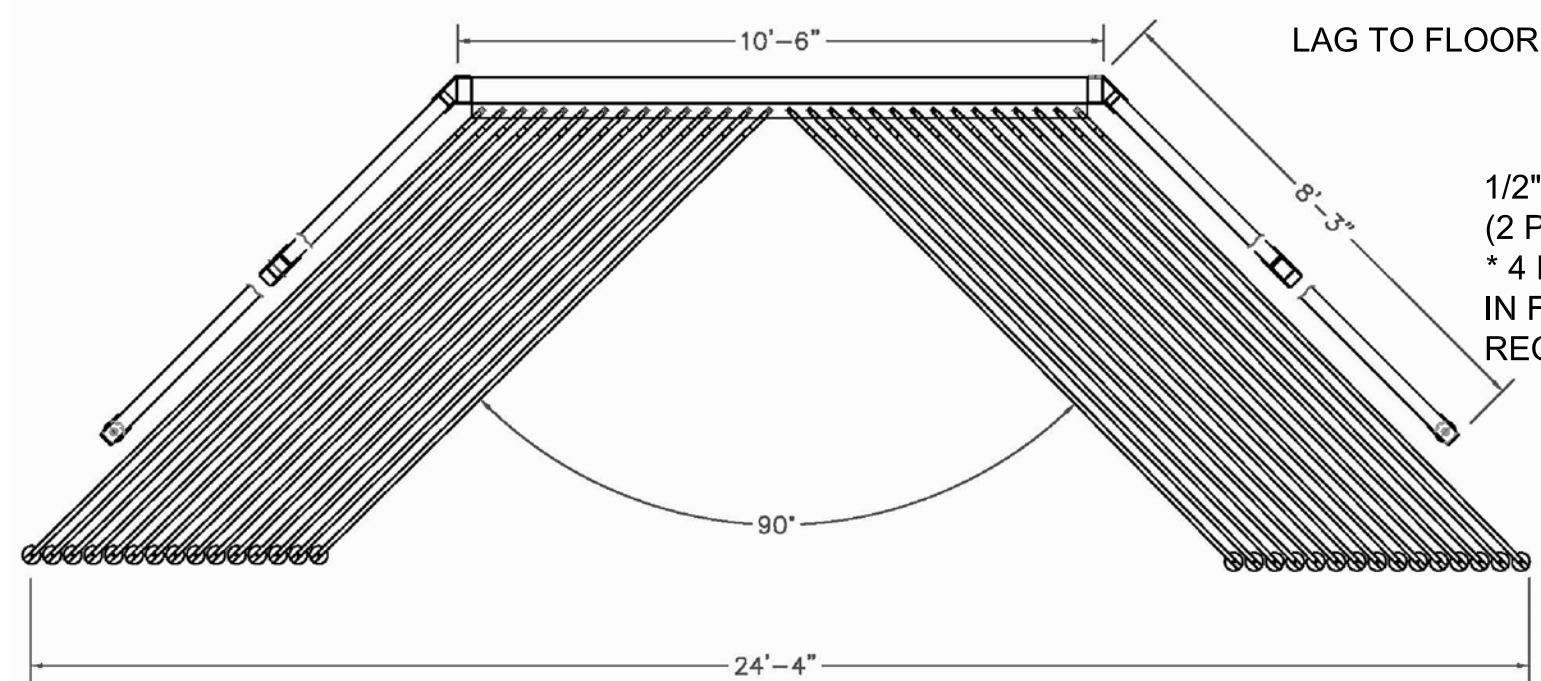

Top View  
Electric Rug Gallery  
3'x12' 30 arm  
Free standing frame foot print

**TOP VIEW OF LEVEL PLATE**  
LAG TO FLOOR  
LAG TO FLOOR  
1/2" X 7" LONG CONCRETE LAG BOLT  
(2 PLACES REQUIRED)  
\* 4 HOLES HAVE BEEN PROVIDED  
IN FRAME FOR AN ALTERNATE IF  
REQUIRED.

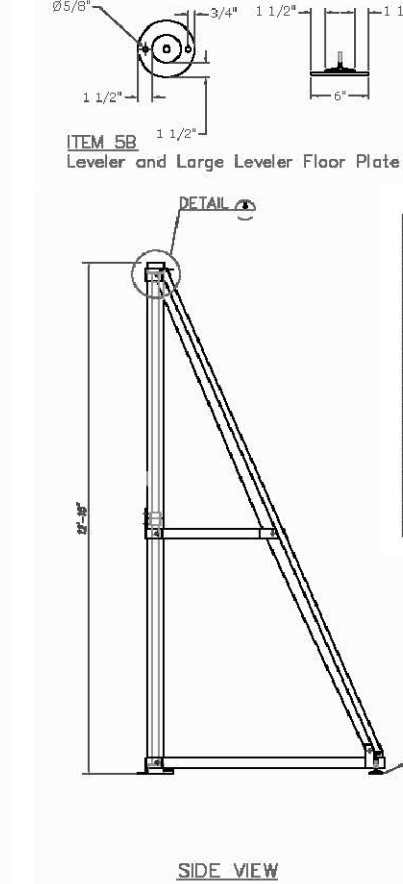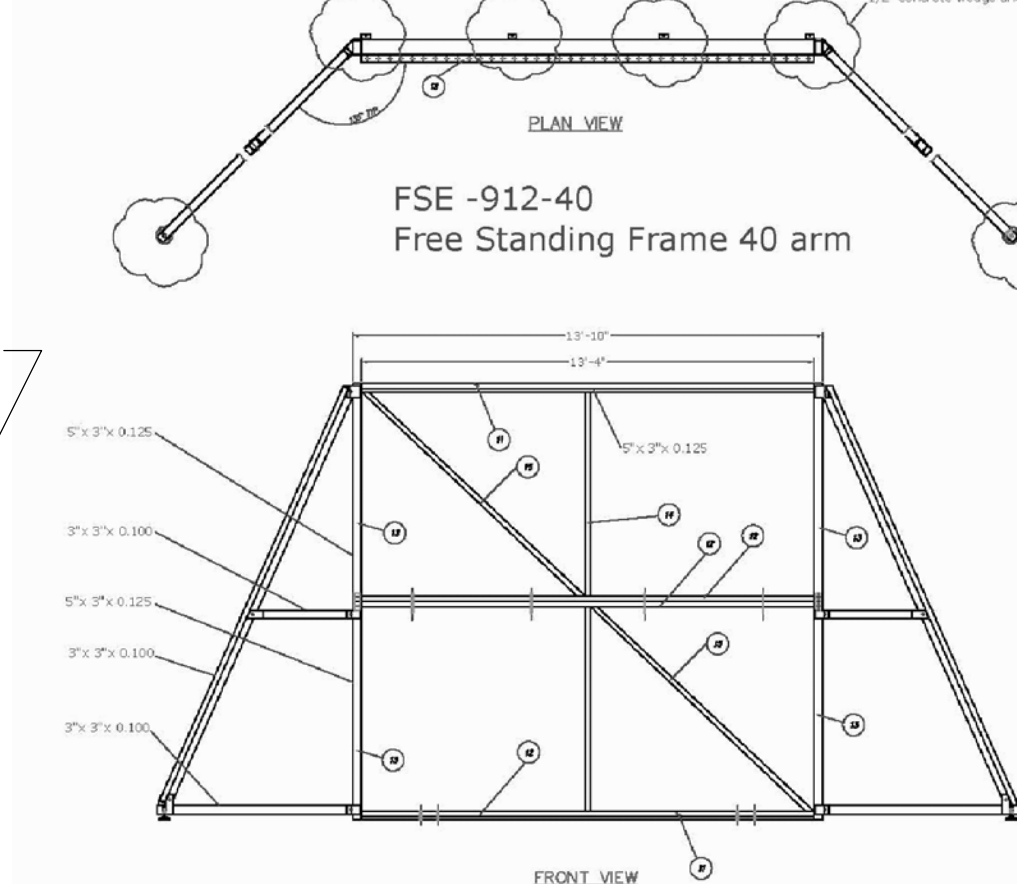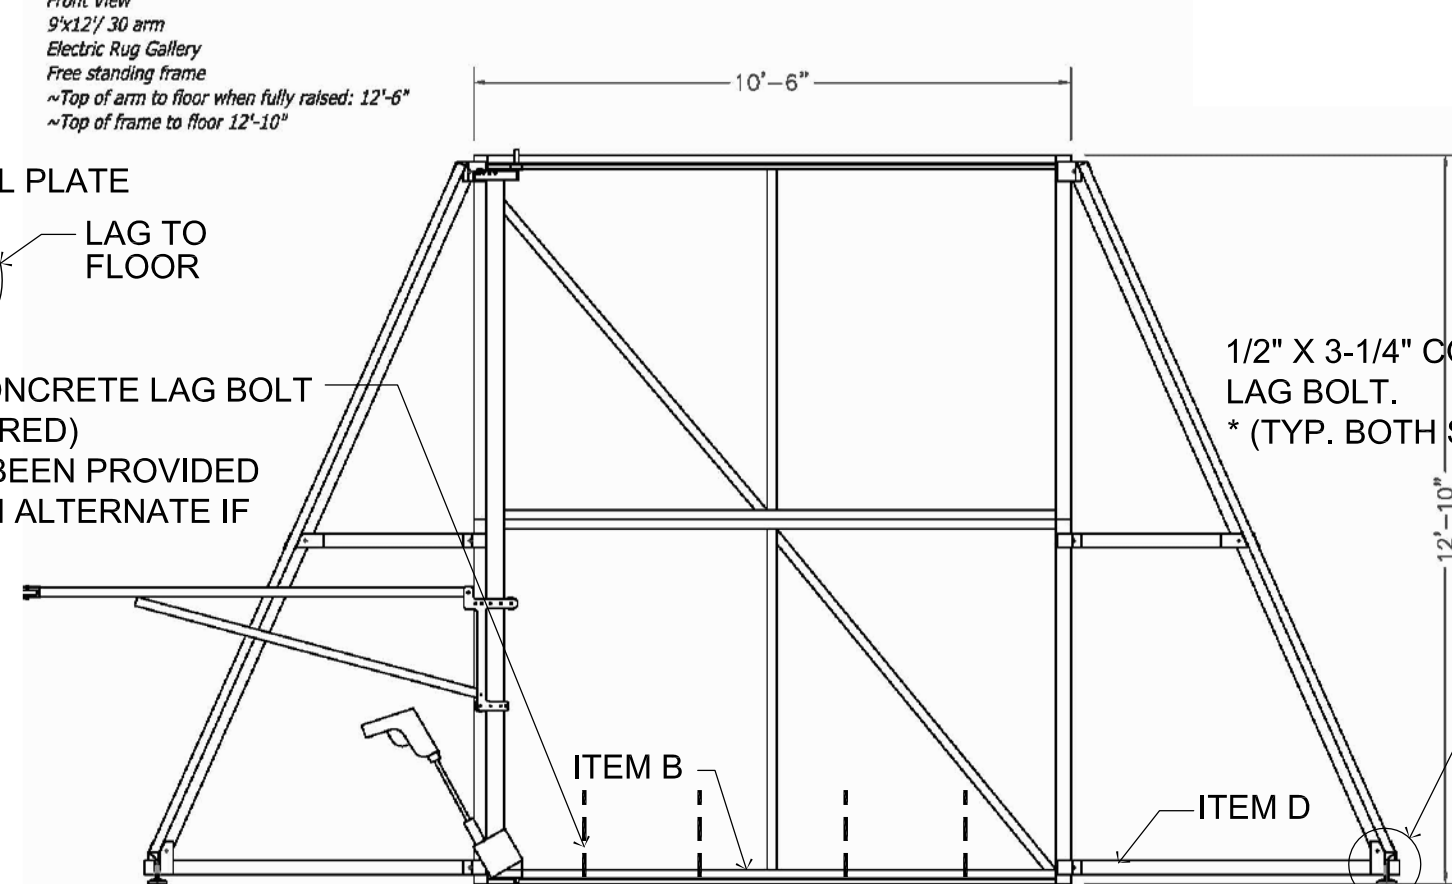

ITEM	DESCRIPTION	QUANTITY	UNIT	REMARKS
1	1/2" X 7" LONG CONCRETE LAG BOLT	8	EA	
2	1/2" X 3-1/4" CONCRETE LAG BOLT	4	EA	
3	1/2" X 3-1/4" CONCRETE LAG BOLT	4	EA	
4	1/2" X 3-1/4" CONCRETE LAG BOLT	4	EA	
5	1/2" X 3-1/4" CONCRETE LAG BOLT	4	EA	
6	1/2" X 3-1/4" CONCRETE LAG BOLT	4	EA	
7	1/2" X 3-1/4" CONCRETE LAG BOLT	4	EA	
8	1/2" X 3-1/4" CONCRETE LAG BOLT	4	EA	
9	1/2" X 3-1/4" CONCRETE LAG BOLT	4	EA	
10	1/2" X 3-1/4" CONCRETE LAG BOLT	4	EA	
11	1/2" X 3-1/4" CONCRETE LAG BOLT	4	EA	
12	1/2" X 3-1/4" CONCRETE LAG BOLT	4	EA	
13	1/2" X 3-1/4" CONCRETE LAG BOLT	4	EA	
14	1/2" X 3-1/4" CONCRETE LAG BOLT	4	EA	
15	1/2" X 3-1/4" CONCRETE LAG BOLT	4	EA	
16	1/2" X 3-1/4" CONCRETE LAG BOLT	4	EA	
17	1/2" X 3-1/4" CONCRETE LAG BOLT	4	EA	
18	1/2" X 3-1/4" CONCRETE LAG BOLT	4	EA	
19	1/2" X 3-1/4" CONCRETE LAG BOLT	4	EA	
20	1/2" X 3-1/4" CONCRETE LAG BOLT	4	EA	
21	1/2" X 3-1/4" CONCRETE LAG BOLT	4	EA	
22	1/2" X 3-1/4" CONCRETE LAG BOLT	4	EA	
23	1/2" X 3-1/4" CONCRETE LAG BOLT	4	EA	
24	1/2" X 3-1/4" CONCRETE LAG BOLT	4	EA	
25	1/2" X 3-1/4" CONCRETE LAG BOLT	4	EA	
26	1/2" X 3-1/4" CONCRETE LAG BOLT	4	EA	
27	1/2" X 3-1/4" CONCRETE LAG BOLT	4	EA	
28	1/2" X 3-1/4" CONCRETE LAG BOLT	4	EA	
29	1/2" X 3-1/4" CONCRETE LAG BOLT	4	EA	
30	1/2" X 3-1/4" CONCRETE LAG BOLT	4	EA	
31	1/2" X 3-1/4" CONCRETE LAG BOLT	4	EA	
32	1/2" X 3-1/4" CONCRETE LAG BOLT	4	EA	
33	1/2" X 3-1/4" CONCRETE LAG BOLT	4	EA	
34	1/2" X 3-1/4" CONCRETE LAG BOLT	4	EA	
35	1/2" X 3-1/4" CONCRETE LAG BOLT	4	EA	
36	1/2" X 3-1/4" CONCRETE LAG BOLT	4	EA	
37	1/2" X 3-1/4" CONCRETE LAG BOLT	4	EA	
38	1/2" X 3-1/4" CONCRETE LAG BOLT	4	EA	
39	1/2" X 3-1/4" CONCRETE LAG BOLT	4	EA	
40	1/2" X 3-1/4" CONCRETE LAG BOLT	4	EA	

**PLAN LEGEND:**

	EXISTING BUILDING GLAZING
	EXISTING CMU BUILDING WALL
	EXISTING NON-BEARING FULL HEIGHT INTERIOR PARTITION
	EXISTING NON-BEARING LOW HEIGHT INTERIOR PARTITION
	MOE PATH OF COMMON EGRESS TRAVEL
	EXIT DISCHARGE
	EMERGENCY EXIT SIGN WITH BACK-UP POWER SOURCE

**7663 BROADWAY BUILDING DATA:**

OCCUPANCY:	GROUP M (NO CHANGE OF USE)
TYPE OF CONSTRUCTION:	V-B
FIRE SPRINKLERS:	UNDER SEPARATE PERMIT (BY HEARTLAND FIRE)
BUILDING AREA:	26,380 S.F.

**7663 BROADWAY OCCUPANT LOAD:**

a. SALES AREA	17,730 S.F. / 60 =	296 OCCUPANTS
b. OFFICE AREA	1,506 S.F. / 150 =	10 OCCUPANTS
c. STOCK AREA	6,319 S.F. / 300 =	21 OCCUPANTS
d. NON-PUBLIC AREA	825 S.F. / 0 =	0 OCCUPANTS
<b>TOTAL OCCUPANT LOAD</b>	<b>26,380 S.F.</b>	<b>327 OCCUPANTS</b>
EXITS REQUIRED:	2	
EXITS PROVIDED:	4 (EXIST. UNCHANGED)	

**7667 BROADWAY OCCUPANT LOAD:**

OCCUPANCY:	GROUP M (NO CHANGE OF USE)
TYPE OF CONSTRUCTION:	V-B
FIRE SPRINKLERS:	UNDER SEPARATE PERMIT (BY HEARTLAND FIRE)
BUILDING AREA:	11,594 S.F.

**7667 BROADWAY BUILDING DATA:**

a. SALES AREA	9,749 S.F. / 60 =	163 OCCUPANTS
b. OFFICE AREA	285 S.F. / 150 =	2 OCCUPANTS
c. STOCK AREA	962 S.F. / 300 =	4 OCCUPANTS
d. NON-PUBLIC AREA	598 S.F. / 0 =	0 OCCUPANTS
<b>TOTAL OCCUPANT LOAD</b>	<b>11,594 S.F.</b>	<b>169 OCCUPANTS</b>
EXITS REQUIRED:	2	
EXITS PROVIDED:	2 (EXIST. UNCHANGED)	

Date: \_\_\_\_\_ Revision: \_\_\_\_\_

Interior design  
space planning  
construction management

**magretti**  
alliam

3160 Camino Del Rio South Suite 307  
San Diego CA 92108

619.624.0521 tel  
619.624.0530 fax

**GTM**  
**7663/7667 BROADWAY**  
**LEMON GROVE, CA**

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Designer: BK  
Sheet No: 1.0

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